



### RIGHT SIDE ELEVATION

### **REAR ELEVATION**

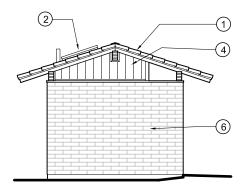


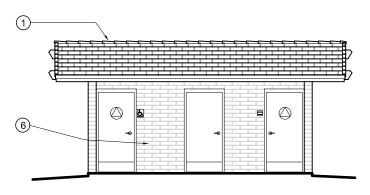

### LEFT SIDE ELEVATION

### FRONT ELEVATION

- 1 CONCRETE TILE ROOF
- (2) SKYLIGHTS
- (3) VENT
- 4 PLYWOOD SIDING
- (5) ELECTRIC METER
- (6) SPLIT FACE CONCRETE MASONRY UNITS

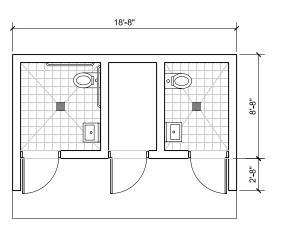

**FLOOR PLAN** 

### ACCESSIBLE COMFORT STATION - LOS LIONES CANYON

SCALE: 1/8" = 1'-0"



SOUTHERN SERVICE CENTER 8885 RIO SAN DIEGO DR, SUITE # 270 SAN DIEGO, CA 92108 PHONE: 619 220-5300 FAX: 619 220-5400

DSA/DPR MOU - 8.01	
ACCESSIBILITY REVIEW	

CERTIFICATION #

Povioused by Date

CALIFORNIA STATE FIRE

MARSHAL APPROVED:
Approval of this plan does not
authorize or approve any omission
of deviation from applicable
regulations. Final approval is
subject to field inspection. One set
of approved plans shall be available
on the project site at all times.

Reviewed by

	REVISIONS
Δ	DATE

# TOPANGA SP PUBLIC USE IMPROVEMENTS ACCESSIBLE COMFORT STATION


DESIGNED:
DRAWN:
REVIEWED BY:
DATE:

PROJECT NUMBER 01609M

SHEET TITLE
ACCESSIBLE
COMFORT STATION

SHEET NO.

FIGURE- 11

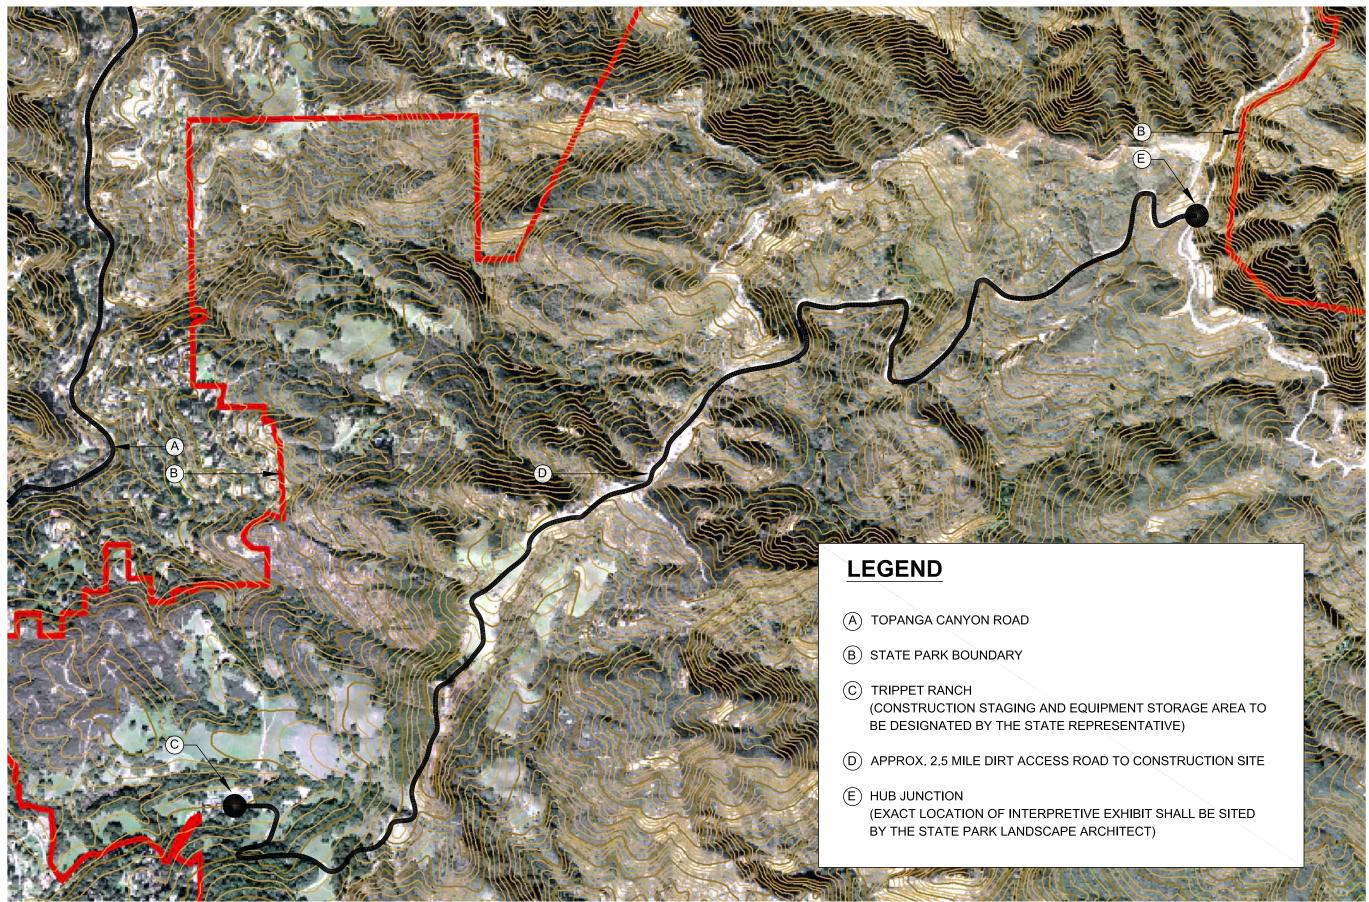

SITE PLAN- HUB JUNCTION

FIGURE- 13 NO SCALE





SOUTHERN SERVICE CENTER 8885 RIO SAN DIEGO DRIVE, SUITE # 270 SAN DIEGO, CA 92108 PHONE: 619 220-5300 FAX: 619 220-5400

DSA/DPR MOU - 8.01 ACCESSIBILITY REVIEW

05071510471044

Reviewed by

CALIFORNIA STATE FIRE MARSHA

Approval of this plan does not authoriz or approve any omission of deviation from applicable regulations. Final approval Is subject to fleld Inspection. One set of approved plans shall be available on the project site at all times

Reviewed by

REVISIONS

A DATE

TOPANGA SP
PUBLIC USE IMPROVEMENTS
SITE PLAN- HUB JUNCTION

DESIGNED: MS

DRAWN: MS/VCD

REVIEWED BY: VCD

DATE: 10/28/04


PROJECT NUMBER


SHEET TI


SITE PLAN-HUB JUNCTION


SHEET NO.

FIGURE- 13

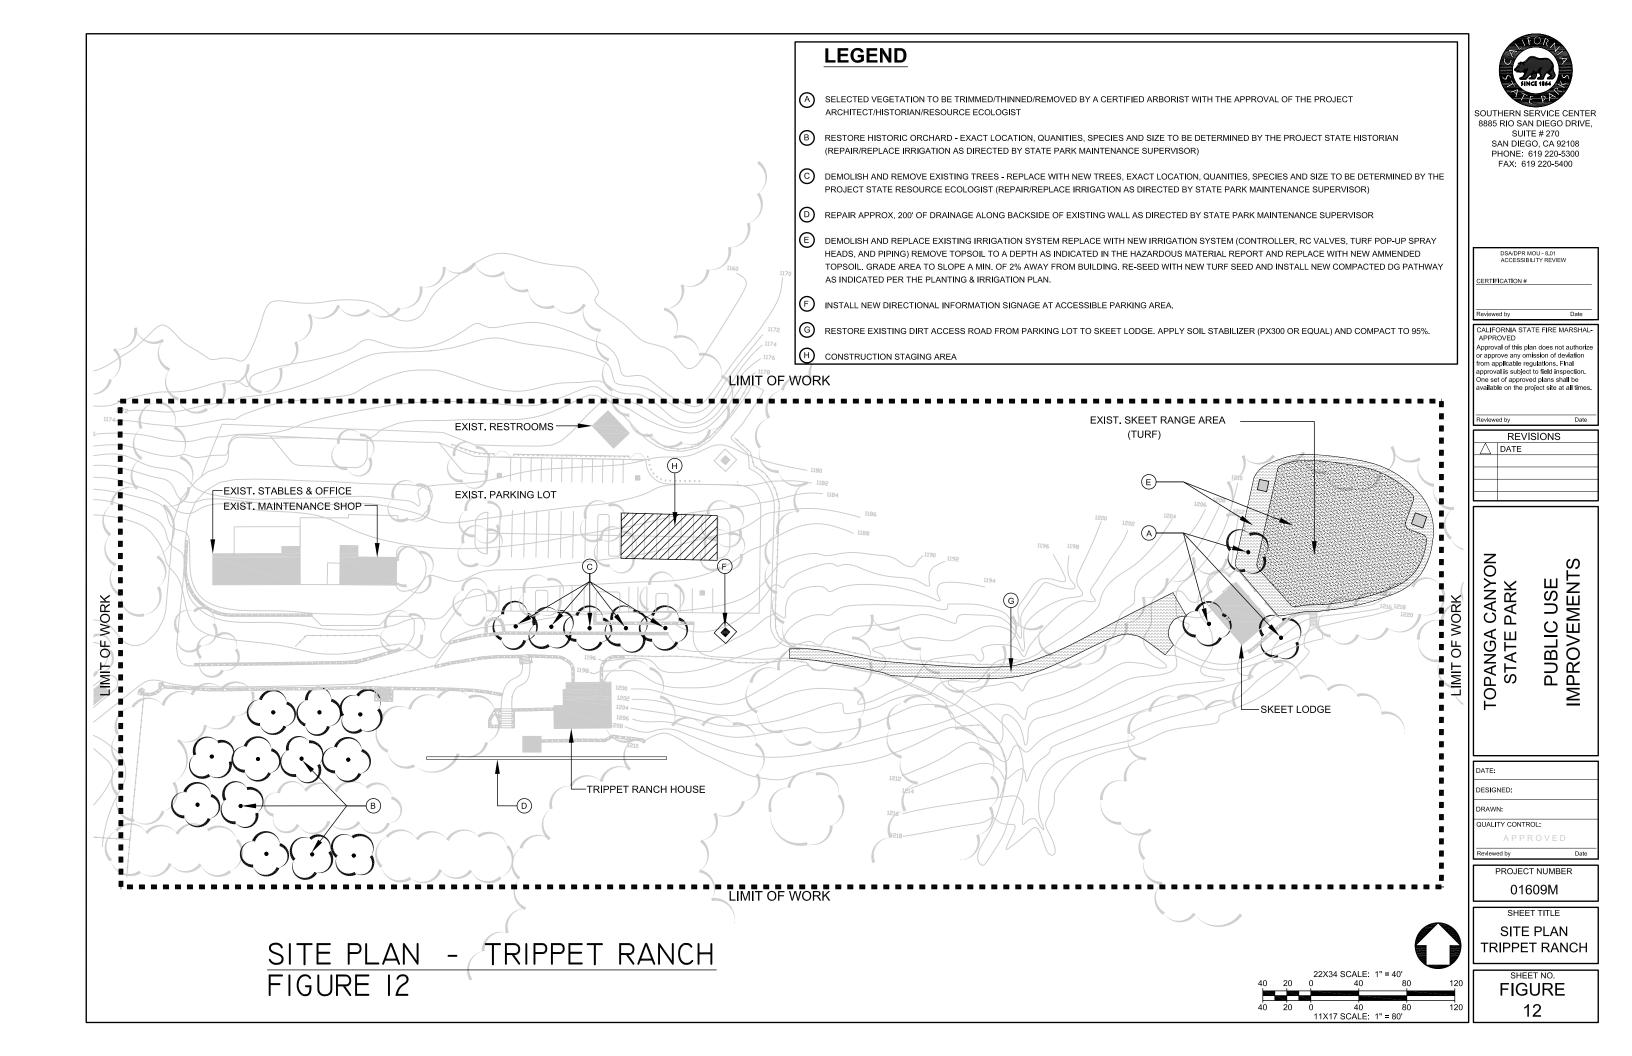


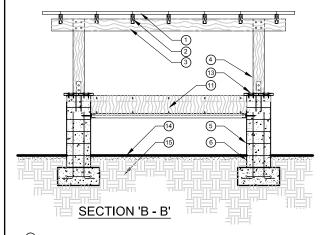

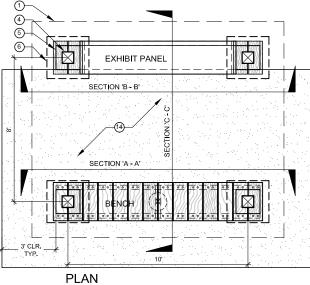

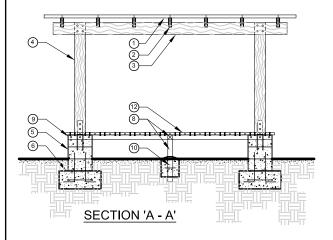

- (1) 24 GA. CORRUGATED METAL ROOFING MATERIAL, ATTACHED TO RAFTER WITH 1 1/2" LONG GALV. ROOFING SCREW.
- 2 2X6 PTDF RAFTER, NOTCHED INTO JOISTS AND SECURED WITH SIMPSON HURRICANE TIES (2 PER EACH CONNECTION).
- (3) 2X8 PTDF JOIST, NOTCH TO ACCEPT RAFTER, ATTACHED TO TOP OF POST WITH 1/2" DIA. 12" LONG GALV. THRU BOLT, COUNTER SINK ENDS (4 PER CONNECTION).
- (4) 8X8 PTDF POST, ATTACHED TO COLUMN BASE WITH SIMPSON CB88 AND 5/8" DIA. BY 8" LONG THRU BOLTS.
- $\begin{picture}(6)\put(0,0){\line(0,0){10}}\put$
- 6 CONCRETE COLUMN FOOTING W/ #4 REBAR HORIZ. RING IN BASE AND (4) #4 REBAR VERT. IN EACH BASE.
- (7) 3" SO. BY 1/4" THK. STEEL CHANNEL HD GALV., ATTACH TO COLUMN WITH 5/8" DIA. BY 3 1/2" LONG GAL. BOLT W/ EXPANSION SHIELD (3 PER CONNECTION).
- $\textcircled{8}\ \ 3"$  SQ. BY 1/4" THK. STEEL TUBE HD GALV., BENCH SUPPORT POST & CROSS BRACE WELD TOGETHER TO 3" CHANNEL (POST TO EXTEND 3" BELOW BOTTOM OF FOOTING).
- $3^{\rm o}$  SQ, BY 1/4" THK, STEEL CHANNEL HD GALV., CONTINUOUS WELD ATTACHMENT TO FRONT 3" CHANNEL & ATTACH TO COLUMN WITH 5/8" DIA, 3 1/2" LONG GAL, BOLT W/ EXPANSION SHIELD (3 PER CONNECTION).
- $\bigoplus$  12" DIA, BY 12" DEEP CONCRETE FOOTING FOR BENCH SUPPORT POST (CROWN TOP OF FOOTING).
- (1) 3/4" THICK MARINE PLYWD, EXHIBIT PANEL BASE ATTACH TO 3" CHANNEL WITH CONTINUOUS WOOD ANGLED FILLER BOARD & COUNTER SUNK 1/2" DIA. BY 3" LONG MACHINE BOLTS @ 24" OC.

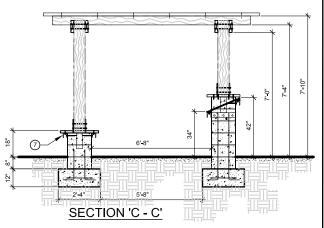

- 12 2X10 PTDF BENCH SEATING BOARDS ATTACH TO 3" CHANNEL WITH 1/2" DIA. BY 3" LONG GALV. CARRIAGE BOLTS (2 @ EA. CONNECTION).
- $\ensuremath{\textcircled{33}}$  2X10 PTDF COLUMN CAP BOARDS ATTACH TO COLUMN WITH 1/2" DIA. BY 3" LONG GALV. LAG BOLT W/ EXPANSION SHIELD.
- $\ensuremath{\textcircled{4}}$  95% COMPACTED STABILIZED DG/SOIL PAVING (STABILIZE WITH PX300 OR APPROVED EQ.).
- 15 95% COMPACTED NATIVE SUBGRADE.

INTERPRETIVE EXHIBIT SHALL BE LOCATED AT THE SITE BY THE STATE LANDSCAPE ARCHITECT AND/OR STATE REPRESENTATIVE.

DURING INTERPRETIVE EXHIBIT CONSTRUCTION & INSTALLATION PEDESTRIAN ACCESS SHALL REMAIN OPEN.

ALL CONSTRUCTION MATERIALS/TOOLS/VEHICLES/DEBRIS SHALL BE REMOVED FROM THE SITE AT THE END OF EACH CONSTRUCTION WORK DAY.

ACCESSIBILITY IS DEPENDENT ON THE PATH OF TRAVEL TO THE INTERPRETIVE EXHIBIT. THE EXISTING DIRT ROAD IS NOT ACCESSIBLE BUT THE EXHIBIT MUST COMPLY W/ THE ACCESSIBLILITY GUIDELINES.

TRANSITION FROM THE EXISTING DIRT ROAD TO THE NEW INTERPRETIVE EXHIBIT SHALL COMPLY WITH CBC 1133B,7.4  $\,$ 

INTERPRETIVE EXHIBIT FLOOR AREA SHALL BE FLAT OR WITH A GRADIENT NOT TO EXCEED 2% IN ANY DIRECTION



SOUTHERN SERVICE CENTER 8885 RIO SAN DIEGO DR, SUITE # 270 SAN DIEGO, CA 92108 PHONE: 619 220-5300 FAX: 619 220-5400

DSA/DPR MOU - 8.01
ACCESSIBILITY REVIEW

CALIFORNIA STATE FIRE

1ARSHAL APPROVED: Approval of this plan does not authorize or approve any omission of deviation from applicable regulations. Final approval is subject to field inspection. One set of approved plans shall be available on the project site at all times on the project site at all times.

### **REVISIONS** DATE

## UBLIC USE IMPROVEMENT **NTERPRETIVE EXHIBIT-TOPANGA SP**

DESIGNED: RR DRAWN: RR

REVIEWED BRR

10/28/04

PROJECT NUMBER 01609M

SHEET TITLE INTERPRETIVE EXHIBIT-**HUB JUNCTION** 

SHEET NO.

FIGURE- 14

### INTERPRETIVE EXHIBIT - HUB JUNCTION

FIGURE-14 SCALE: 3/16" = 1'-0"